



**SOUTHBOUND  
WEST SIDE PROFILES**

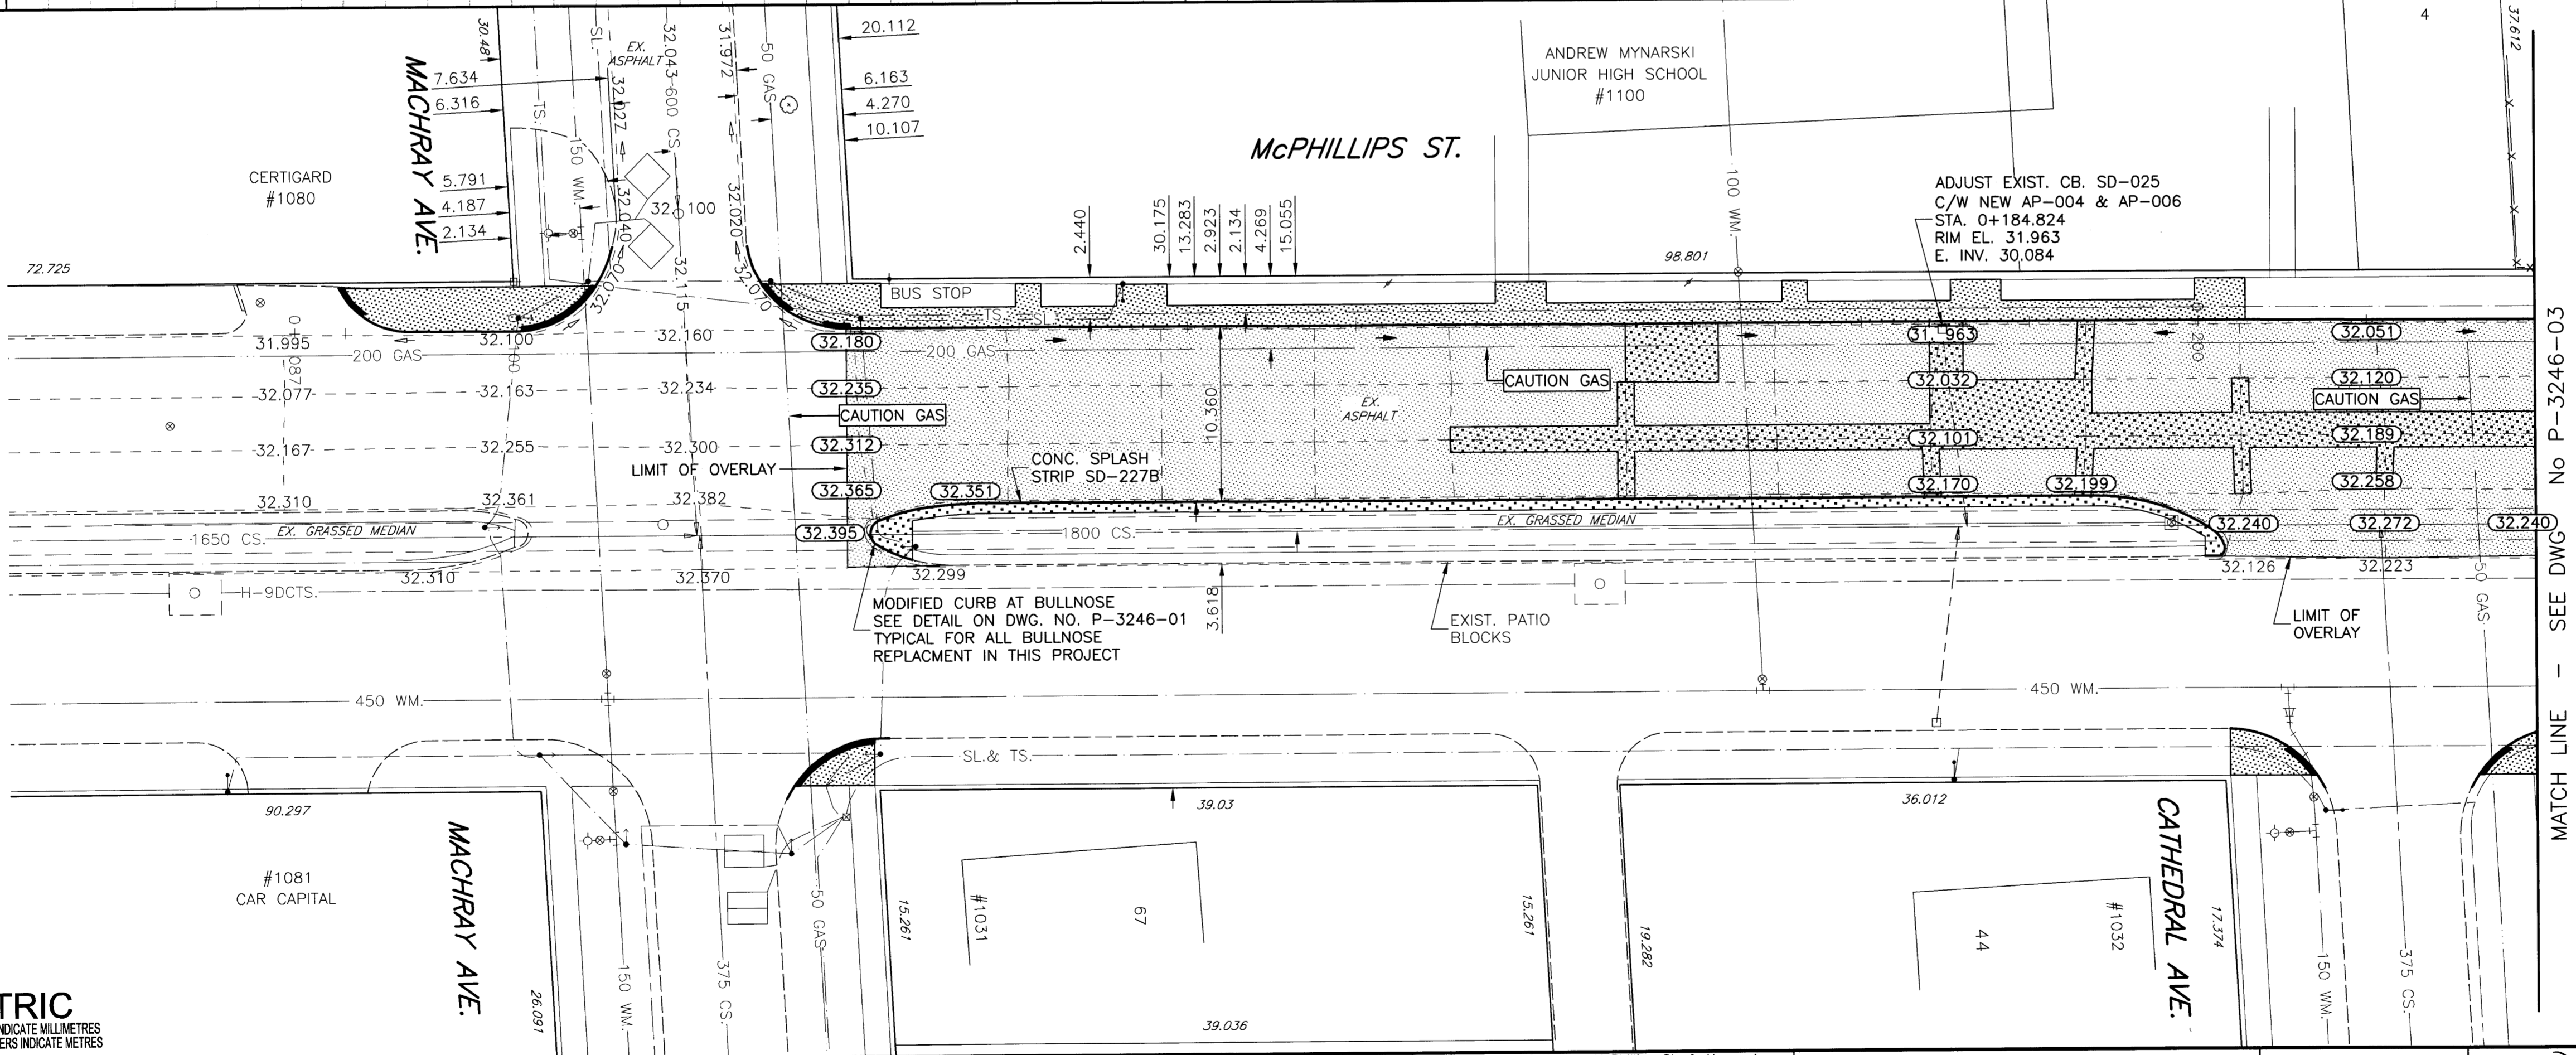

NOTE  
THE AVERAGE ASPHALT THICKNESS TO BE  
PLACED ON THIS PROJECT IS 90mm (2-LIFTS).

- NOTES
1. ADJUST EXISTING MH. AND CB. RIMS TO NEW GRADES.
  2. ADD 200.000m TO ABBREVIATED ELEVATIONS FOR GEODETIC ELEVATIONS.

BID  
OPPORTUNITY  
No. 25-2004

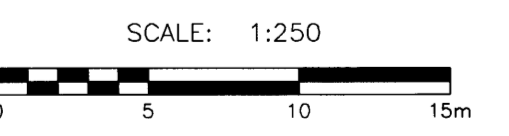

**APEGM**  
Certificate of Authorization  
UMA Engineering Ltd.  
No. 256 Expiry: April 30, 2004

**METRIC**  
WHOLE NUMBERS INDICATE MILLIMETRES  
DECIMALIZED NUMBERS INDICATE METRES

EXISTING	LEGEND - PLAN	PROPOSED	EXISTING	LEGEND - PLAN	PROPOSED	EXISTING	LEGEND - PLAN	PROPOSED
○	MANHOLE	●	○	MANHOLE	●	▨	CONCRETE PAVEMENT	▨
□	CATCH BASIN/CATCH PIT	■	□	CATCH BASIN/CATCH PIT	■	▩	ASPHALT PAVEMENT	▩
△	C & G INLET W/BOX	▲	△	C & G INLET W/BOX	▲	▩	CONC. SIDEWALK/MED. SLAB	▩
⊙	TREE	⊙	⊙	TREE	⊙	▩	PAVING STONE	▩
⊕	TEST HOLE	⊕	⊕	TEST HOLE	⊕	▩	TOPSOIL & SOD	▩
—	PROPERTY LINE	—	—	PROPERTY LINE	—	▩	GRAVEL	▩
—	SURVEY BAR	—	—	SURVEY BAR	—	▩	RAMP CURB	▩
—	FENCE	—	—	FENCE	—	▩	REMOVAL	▩
—	BACK OF CURB	—	—	BACK OF CURB	—			
←	ELEVATION	←	←	ELEVATION	←			

**LOCATION APPROVED**  
UNDERGROUND STRUCTURES  
*Robert M. Spina* March 25, 04  
DATE: 04/03/25

NOTE:  
LOCATION OF UNDERGROUND STRUCTURES AS SHOWN ARE BASED ON THE BEST INFORMATION AVAILABLE. BUT NO GUARANTEE IS GIVEN THAT ALL EXISTING UTILITIES ARE SHOWN OR THAT THE GIVEN LOCATIONS ARE EXACT. CONFIRMATION OF EXISTENCE AND EXACT LOCATION OF ALL SERVICES MUST BE OBTAINED FROM THE INDIVIDUAL UTILITIES BEFORE PROCEEDING WITH CONSTRUCTION.

**UMA** **UMA Engineering Ltd.**  
• Consulting • Engineering • Construction • Management Services

DESIGNED BY: WRJ  
CHECKED BY: [Signature]  
DRAWN BY: DID  
APPROVED BY: [Signature]  
HOR. SCALE: 1:250  
VERTICAL: 1:10  
ISSUED FOR CONSTRUCTION: 04Mar25  
DATE: 04/03/25

ENGINEER'S SEAL  
PROVINCE OF MANITOBA  
R.P. BRUCE  
REGISTERED PROFESSIONAL ENGINEER  
CONSULTANT DRAWING NO. 41-09-0265-365-01

**THE CITY OF WINNIPEG**  
PUBLIC WORKS DEPARTMENT  
ENGINEERING DIVISION

**STREET RENEWAL**  
McPHILLIPS STREET SOUTHBOUND  
MACHRAY AVENUE TO MAPLEGLLEN AVENUE  
HORIZONTAL & VERTICAL ALIGNMENT  
STA. 0+100.000 TO STA. 0+220.000

CITY DRAWING NUMBER: P-3246-02  
SHEET: 2 OF 7  
REV: 02  
A

PLOT SCALE = 1:10.25  
AutoCAD 15.05 P:\02665\365-00\ALD\McPhillips.dwg\McPhillips Site Plan.dwg 2004-03-24 4:37pm DID