


LOOKING EAST ALONG RIVERBANK TOE DATE 2020-10

- 1. ALL EXCAVATED MATERIAL WITHIN 107.0 OF THE ASRL MUST BE REMOVED FROM SITE (NO STOCKPILING).
- 2. CONSTRUCT TEMPORARY CLAY COFFERDAM OR SANDBAG DIKE AT RIVER AS REQUIRED TO FACILITATE CLEANING.
- 3. PERMITS AS REQUIRED FOR CONSTRUCTION OF TEMPORARY ACCESS ARE THE RESPONSIBILITY OF THE CONTRACTOR.
- 4. ALL MATERIALS, INCLUDING TEMPORARY MATERIAL PLACED FOR CONSTRUCTION EQUIPMENT ACCESS AND PADS, MUST BE REMOVED FROM SITE FOLLOWING COMPLETION OF CLEANING WORKS.
- 5. DUE TO SITE RESTRAINTS AND TO AVOID IMPACTING AND/OR CAUSING DAMAGE TO ADJACENT PROPERTIES, THE CONTRACTOR SHALL DEVELOP ALTERNATE ACCESS ROUTE THROUGH EXISTING PARK SPACE TO ACCESS PIPE OUTLET. SEE POTENTIAL ACCESS ROUTE BELOW. TO BE COORDINATED WITH PARKS AND THE CONTRACT ADMINISTRATOR.
- 6. CONTRACTOR IS ADVISED THAT TEMPORARY CONSTRUCTION ACCESS AGREEMENTS WITH ADJACENT HOME OWNERS ARE EXPECTED TO BE IN PLACE AT TIME OF CONSTRUCTION. CONTRACTOR TO PROVIDE ACCESS PLAN AND EQUIPMENT LIST TO THE CONTRACT ADMINISTRATOR A MINIMUM OF FIVE (5) BUSINESS DAYS PRIOR TO STARTING CONSTRUCTION. CONTRACTOR NOT TO ACCESS SITE WITHOUT CONTRACT ADMINISTRATOR'S APPROVAL.





PIPE OUTLET DATE 2020-10

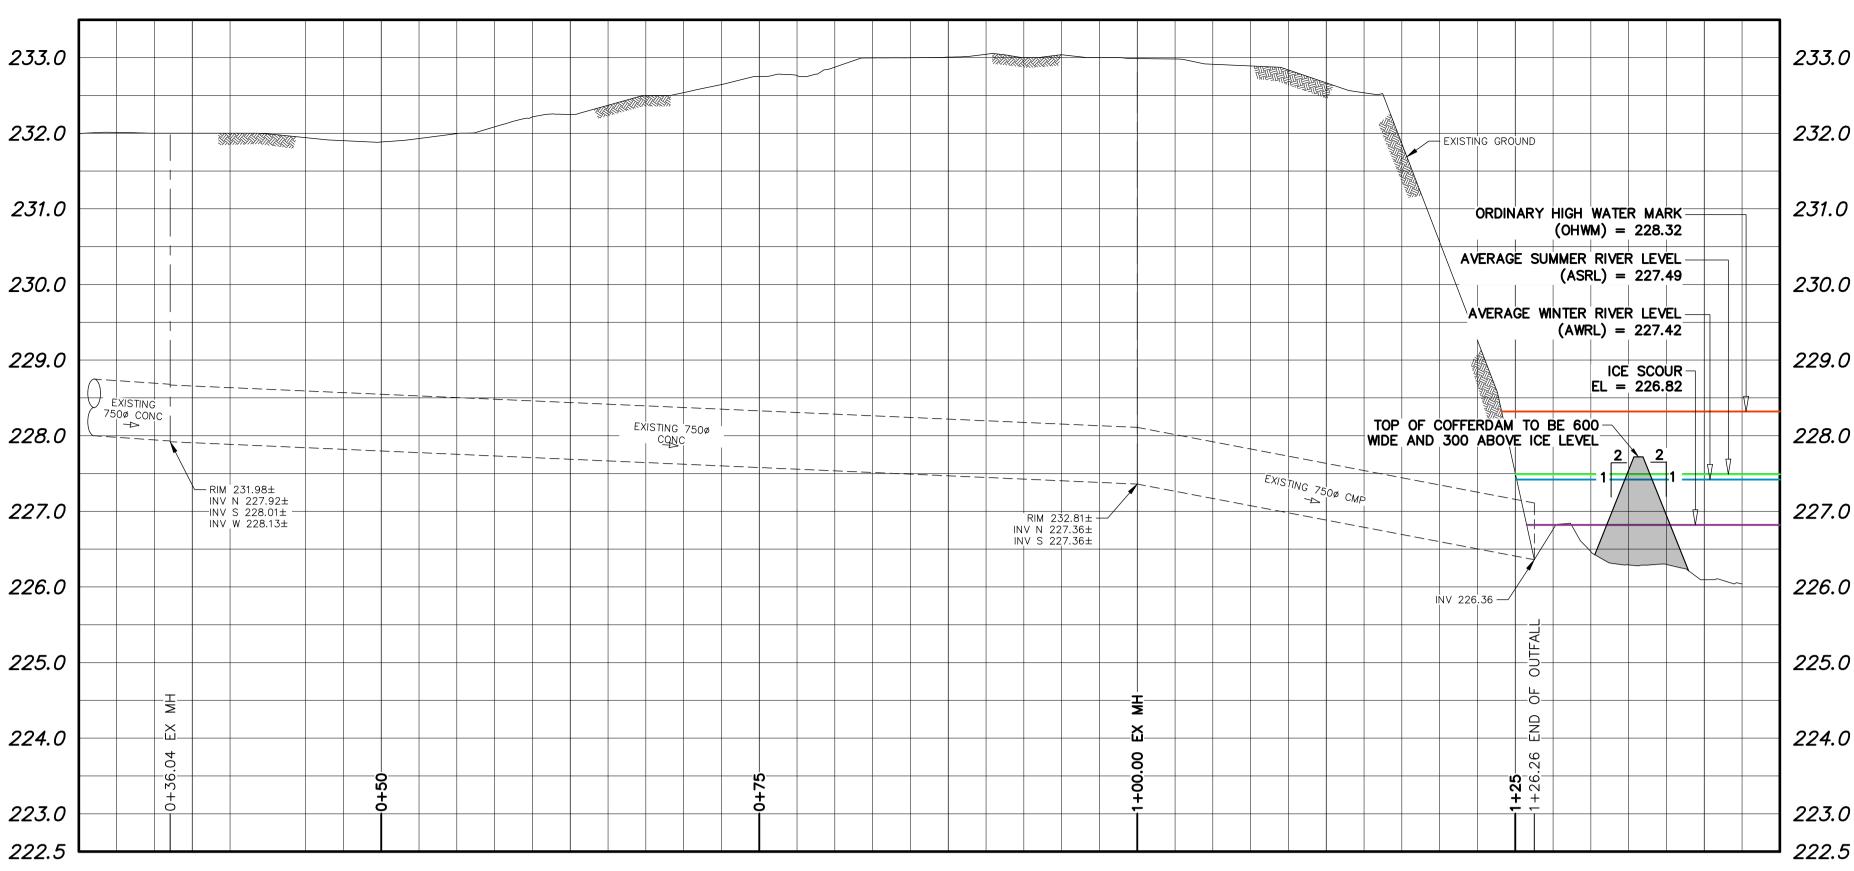

NOTE: CHAINAGES SHOWN ARE ALONG & EXISTING OUTFALL

SUBSTRATE TYPES BELOW ICE SCOUR AFFECTED BY THE PROJECT PERMANENT TEMPORARY EXISTING SUBSTRATE AREA (m²) AREA (m²)COBBLE/GRAVEL/SAND 0.0 0.0 COBBLE WITH SAND 0.0 0.0 GRAVEL/SAND WITH SOME CLAY 0.0 47.0 SAND/GRAVEL/CLAY 7.2 0.0 SAND WITH CLAY 0.0 36.9 CLAY WITH SAND 0.0 0.0 SILTY SAND 0.0 0.0 TOTAL AREA AFFECTED 0.0 91.1

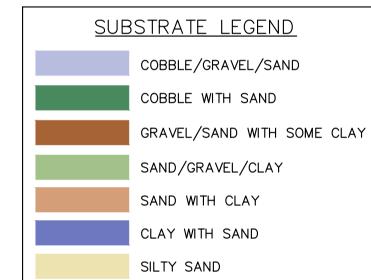

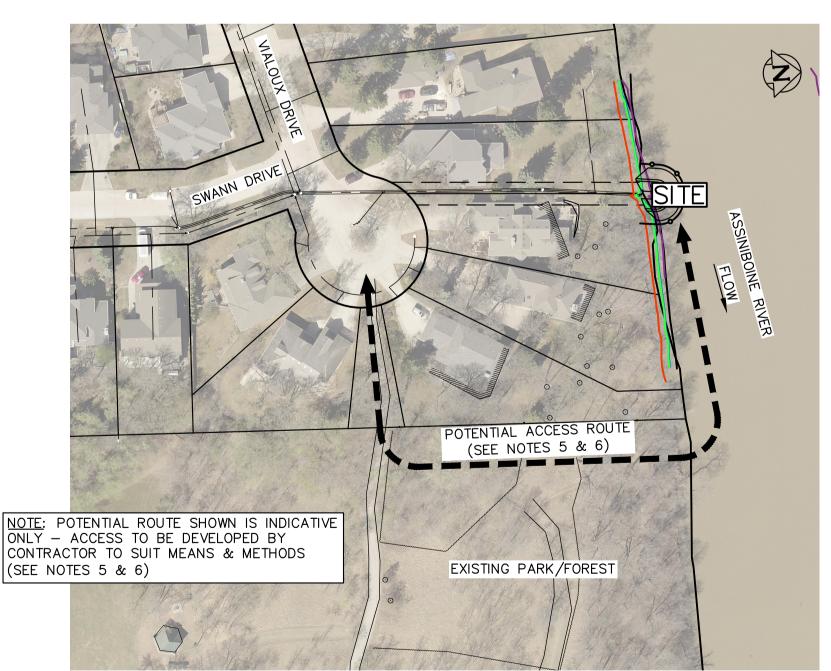

— AWRL (EL 227.42) -ICE SCOUR (EL 226.82) SINIBOINE OUTFALL LENGTH TO BE CLEANED = 90.2 CONTRACTOR TO CLEAN OUTFALL USING STANDARD CLEANING METHODS PROPOSEÓ EXTENTS OF TEMPORARY CLAY COFFERDAM CONTRACTOR TO INSPECT OUTFALL FOLLOWING COMPLETION OF CLEANING (TOTAL AREA = 111.5m²)AREA TO BE TEMPORARILY $DE-WATERED = 3.2m^2$ INSTALL SAFETY FENCING AT OUTLET AS REQUIRED TO SECURE SITE AND PROTECT PUBLIC REMOVE SILT BUILD UP IN FRONT OF PIPE OUTLET CONTRACTOR TO REMOVE TREES AS REQUIRED FOR ACCESS AND AS DIRECTED BY THE CONTRACT ADMINISTRATOR PROTECT EXISTING TREES THROUGHOUT CONSTRUCTION E G NGINEERS AS REQUIRED TO FACILITATE CLEANING, THE CONTRACTOR-PLAN SCALE 1:250 AS DIRECTED BY THE CONTRACT ADMINISTRATOR OSCIENTISTS SHALL DEVELOP ACCESS THROUGH EXISTING PARK SPACE MANITOBA TO ACCESS OUTLET (SEE NOTES 5 & 6) Certificate of Authorization

POTENTIAL ACCESS ROUTE SCALE: N.T.S.

FOR INDEX PAGE SEE DWG 1-03030-D0009-001

> METRIC WHOLE NUMBERS INDICATE MILLIMETRES DECIMALIZED NUMBERS INDICATE METRES

WARNING

IF POWER EQUIPMENT OR EXPLOSIVES ARE TO BE USED FOR EXCAVATION ON THIS PROJECT THE CONTRACTOR MUST:

1) NOTIFY THE GAS COMPANY OF THE PROPOSED LOCATION OF EXCAVATION. 2) TAKE PRECAUTION TO AVOID DAMAGE

SEE PROVINCIAL REGULATION 210/72 FOR DETAILS

TO GAS COMPANY INSTALLATIONS.

SUPV. U/G STRUCTURES COMMITTEE NOTE: LOCATION OF UNDERGROUND STRUCTURES AS SHOWN ARE BASED ON THE BEST INFORMATION AVAILABLE BUT NO GUARANTEE IS GIVEN THAT ALL EXISTING UTILITIES ARE SHOWN OR THAT THE GIVEN LOCATIONS ARE EXACT. CONFIRMATION OF EXISTENCE AND EXACT LOCATION OF ALL SERVICES MUST BE OBTAINED FROM THE INDIVIDUAL UTILITIES BEFORE PROCEEDING WITH CONSTRUCTION.

ENGINEER'S SEAL LOCATION APPROVED KGS ELEV. UNDERGROUND STRUCTURES CHECKED DESIGNED NGV APPROVED DRAWN SCALE: RELEASED FOR CONSTRUCTION HORIZONTAL 1:250 CONSULTANT DRAWING NUMBER 1:50 VERTICAL ISSUED FOR TENDER REVISIONS DATE 2021 11 04

2021 11 04

Winnipeg

THE CITY OF WINNIPEG WATER AND WASTE DEPARTMENT ENGINEERING DIVISION

-OHWM (EL 228.32)

- ASRL (EL 227.49)

2020-2021 OUTFALL PROGRAM

CLEANING 3087 VIALOUX DRIVE OUTFALL PLAN AND PROFILE

1-03030-C0058-001 S-MA60003875

SHEET **21** OF **26**

CITY DRAWING NUMBER

BID OPPORTUNITY: 628-2021 CONTRACT NUMBER:

1-03030-C0058-001

KGS Group

No. 245

FILE PATH: P:\Projects\2020\20-0107-010\Dwg\Mun\FILE NAME: 20-0107-010_2022 PP-C.dwg